



GALVESTON COUNTY ENGINEERING DEPARTMENT

Change Order No. 01
Bacliff Drainage Improvements

Owner: Galveston County
Contractor: Lucas Construction Co.
Engineer: Gannett Fleming Transystems

Contract Number: CM25015
Purchase Order Number: F502913
Bid Number: 24-025

Work Being Changed

Adjusting the bid items to accommodate the increase in Item 19 – CL A Concrete (Channel Lining) (8") SY, and to include the addition of four concrete pads over existing storm pipes in lieu of grates with Item 18 - CL A Concrete (Channel Lining) (6") SY.

CHANGE IN CONTRACT PRICE

Original Contract Price: **\$1,698,700.00**
Net Change From
Previous Change Orders: **\$0**
Contract Price Prior To
This Change Order: **\$1,698,700.00**
Net Increase/Decrease Of
This Change Order: **\$0**
Contract Price With All
Approved Change Orders: **\$1,698,700.00**

CHANGE IN CONTRACT TIME

Original Contract Time: **360 Days**
Net Change From
Previous Change Orders: **0 Days**
Contract Time Prior To
This Change Order: **360 Days**
Net Increase/Decrease Of
This Change Order: **0 Days**
Contract Time With All
Approved Change Orders: **360 Days**

RECOMMENDED:

By: Ryan Ramirez *Rmz* Date: 04/17/2025
Engineer (Consultant)

By: *[Signature]* Date: 4/17/2025
Engineer (County Engineer)

APPROVED:
County Of Galveston

By: _____ Date: _____
Mark Henry, County Judge

Attest: _____
Dwight Sullivan, County Clerk

ACCEPTED:
Contractor

By: *[Signature]* Date: 4/17/2025
Contractor (Authorized Signature)

Jimmy McGinnis
Printed Name

GALVESTON COUNTY ENGINEERING DEPARTMENT

Change Order No. 01
Bacliff Drainage Improvement

Pay Item No.	Spec Item No.	DESCRIPTION	UNIT	UNIT PRICE	QUANTITY	ITEM COST	QUANTITY	ITEM COST	OVERRUN/UNDERRUN
19		CL A CONC(CHANNEL LINING)(8")	SY	\$260.00	90.00	\$23,400.00	380.00	\$98,800.00	-\$75,400.00
9		STEEL GRATING	LF	\$600.00	85.00	\$51,000.00	0.00	\$0.00	\$51,000.00
28		Port CTB(FUR and INST)(Low Profile)(TY 1)	LF	\$200.00	40.00	\$8,000.00	0.00	\$0.00	\$8,000.00
29		Port CTB(FUR and INST)(Low Profile)(TY 2)	LF	\$200.00	40.00	\$8,000.00	0.00	\$0.00	\$8,000.00
30		Port CTB(Remove)(Low Profile)(TY 1)	LF	\$100.00	40.00	\$4,000.00	0.00	\$0.00	\$4,000.00
35		Rock Filter Dams(Install)(TY 2)	LF	\$30.00	150.00	\$4,500.00	0.00	\$0.00	\$4,500.00
36		Rock Filter Dams(Remove)	LF	\$30.00	150.00	\$4,500.00	0.00	\$0.00	\$4,500.00
18		CL A CONC(CHANNEL LINING)(6")	SY	\$200.00	440.00	\$88,000.00	463.00	\$92,600.00	-\$4,600.00
		TOTAL							\$0.00



March 26, 2025
Gannett Fleming
3100 Alabama St
Houston, TX 77098
ATTN: Ryan Ramirez
RE: Bacliff Drainage CPR #1 – RFI 01 Low Water Crossing

Mr. Ramirez,

In response to the answer to RFI 01, Lucas Construction Company, Inc. proposes to provide labor, materials, equipment, layout, supervision, and insurance to accomplish the additional work for the following lump sum amount:

-Increase quantity to line 19 by 290 SY for a revised total of 380 SY	\$260/SY	\$75,400
-Remove bid item 9		(\$51,000)
-Add (4) concrete pads over existing storm pipes in lieu of grates	\$1,150/EA	\$4,600
-Remove bid items 28-30 (not needed)		(\$20,000)
-Remove bid items 35 and 36 (we can use silt fence if needed)		(\$9,000)

Net Increase in Base Bid = \$0.00

Exclusions: Engineering, permitting, materials testing, well-pointing, and any utility adjustments/relocations that may be necessary.

Please feel free to call me at 281-316-9990 with any questions or concerns.

Sincerely,

A handwritten signature in black ink, appearing to read "J. McGinnis", is written over a horizontal line.

Jimmy McGinnis
Vice President
Lucas Construction


1. RFI No.: 01
2. Project Name: **Bacliff Drainage Improvements**
3. Contractor: **Lucas Construction Company, Inc.**
4. Specification No.: Low Water Crossing Concrete Quantity
5. Drawing No.: Sheet 29
6. Response Code: () CRITICAL (X) ROUTINE
7. Date Response Required: **01/22/2024**
8. Information Required:

Items 17-19 of the bid form are for (3) different concrete linings. Item 17 has 160 SY of 5" concrete, which we believe is for the concrete floor between the FW and SW walls. The TXDOT detail shows the floor to be 5" thick. That is the only area of the project we can find 5" concrete. Item 18 has 440 SY of 6" concrete, which we believe is for the concrete channel at the Bayshore outfall. The detail for that concrete on sheet 31 shows 6" concrete and the quantity is very close. That leaves item 19 for the low water crossing shown on sheet 29. Item 19 only has 90 SY of 8" concrete, but if I scale the layout on sheet 29 and take into consideration the 5:1 slope, I get 380 SY of concrete. I cannot locate a detail for the low water crossing, I'm only assuming it is 8" thick because that's the only concrete bid item left that could account for this work. Please advise if this is correct and if we are to overrun bid item 19 or if this will need to be paid differently.

[Handwritten signature]

9. _____ Vice President 01/15/2024
Contractor Signature Title Date

10. **RESPONSE:**
See below in attached Gannett Fleming document for response.

11.  01/21/2025
Project Manager Signature Date

12. **If Contractor believes the response given in Item 10 requires an adjustment in Contract Price or Contract Time, Contractor shall submit a timely proposal so as not to delay Contractor's Work.**

END OF DOCUMENT

REQUEST FOR INFORMATION CONSTRUCTION PHASE

RFI Number: 01

To:	Jimmy McGinnis (Lucas Construction)	Project:	Galveston County ARPA BackflS Drainage Improvements
	Tim Morrow (Lucas Construction) , Nancy Baher (Galveston County), Lisa Butler (Galveston County)		
		Contract:	Project: No. ITB 24-025
From:	Donald Stephanik (Gannett Fleming TranSystems)	Reference:	Channel Lining
	Ryan Ramirez (Gannett Fleming TranSystems)	Spec. Section:	
Date:	01/21/2025	Drawing No:	

Request:

Items 17-19 of the bid form are for (3) different concrete linings. Item 17 has 160 SY of 5" concrete, which we believe is for the concrete floor between the FW and SW walls. The TXDOT detail shows the floor to be 5" thick. That is the only area of the project we can find 5" concrete. Item 18 has 440 SY of 6" concrete, which we believe is for the concrete channel at the Bayshore outfall. The detail for that concrete on sheet 31 shows 6" concrete and the quantity is very close. That leaves item 19 for the low water crossing shown on sheet 29. Item 19 only has 90 SY of 8" concrete, but if I scale the layout on sheet 29 and take into consideration the 5:1 slope, I get 380 SY of concrete. I cannot locate a detail for the low water crossing, I'm only assuming it is 8" thick because that's the only concrete bid item left that could account for this work. Please advise if this is correct and if we are to overrulen bid item 19 or if this will need to be paid differently.

Attachments: RFI PDF**Requested By:** Jimmy McGinnis**Date:** 01/15/25**Please Respond By:** Ryan Ramirez**Response:**

After reviewing the design documents, Item 19 CL A CONC(CHANNEL LINING)(8") is the correct item for the low water crossing. The crossing will have 8-inch concrete on the main driving surface and the channel bottom just upstream and downstream of the crossing, and 6-inch on the side slopes. The original estimate shows the low water crossing quantities in the 5-inch and 8-inch rows; the total was 250 SY. The total area needs to be 415 SY instead of the 250 SY, with 157 SY of 6-inch concrete and 258 SY of 8-inch concrete. The contractor's fee will increase by \$35,080. The 5-inch concrete quantity does not include the headwall apron, as estimated by the contractor. The bid tab shows the headwall as an individual unit and does not require additional estimation of concrete items. This will cause for a change order.

Responded By: Ryan Ramirez**Signed:** **Response/Return Date:** 01/21/2025**Copies To:** RFI Log

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- 1
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4. CONSTRUCTION NOTES

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5. SURVEY CONTROL - OVERALL
6. SURVEY CONTROL DETAIL SHEET
7. SURVEY CONTROL DETAIL SHEET
8. PROJECT LAYOUT (SHEET 1 OF 2)
9. PROJECT LAYOUT (SHEET 2 OF 2)

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11. DEMO SHEETS (SHEET 2 OF 5)
12. DEMO SHEETS (SHEET 3 OF 5)
13. DEMO SHEETS (SHEET 4 OF 5)
14. DEMO SHEETS (SHEET 5 OF 5)

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16. N-16 EAST DITCH (SHEET 2 OF 7) STA 5+00 TO STA 10+00
17. N-16 EAST DITCH (SHEET 3 OF 7) STA 10+00 TO STA 15+00
18. N-16 EAST DITCH (SHEET 4 OF 7) STA 15+00 TO 20+00
19. N-16 EAST DITCH (SHEET 5 OF 7) STA 20+00 TO 25+00
20. N-16 EAST DITCH (SHEET 6 OF 7) STA 25+00 TO STA 30+00
21. N-16 EAST DITCH (SHEET 7 OF 7) STA 30+00 TO END
22. N-16 WEST DITCH (SHEET 1 OF 7) BEGIN TO STA 36+00
23. N-16 WEST DITCH (SHEET 2 OF 7) STA 36+00 TO STA 41+00
24. N-16 WEST DITCH (SHEET 3 OF 7) STA 41+00 TO STA 46+00
25. N-16 WEST DITCH (SHEET 4 OF 7) STA 46+00 TO STA 51+00
26. N-16 WEST DITCH (SHEET 5 OF 7) STA 51+00 TO STA 56+00
27. N-16 WEST DITCH (SHEET 6 OF 7) STA 56+00 TO STA 61+00
28. N-16 WEST DITCH (SHEET 7 OF 7) STA 61+00 TO END
29. 10TH STREET CHANNEL (SHEET 1 OF 1) STA 66+00 TO END
30. BAYSHORE OUTFALL STA 86+00 TO END
31. BAYSHORE OUTFALL SLAB DETAIL & N16 EAST OUTFALL DETAIL
32. UTILITY PLAN & PROFILE (SHEET 1 OF 4)
33. UTILITY PLAN & PROFILE (SHEET 2 OF 4)
34. UTILITY PLAN & PROFILE (SHEET 3 OF 4)
35. UTILITY PLAN & PROFILE (SHEET 4 OF 4)

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38. N-16 WEST DITCH COORDINATE LAYOUT (SHEET 1 OF 2)
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DEC

ENGINEERING EXCELLENCE

T.B.P.E.L.S. FIRM REGISTRATION #392
3100 WEST ALABAMA HOUSTON, TEXAS 77068 (713) 524-9570

SEAL

STATE OF TEXAS

MOUNIKA JELLA

146004

LICENSED PROFESSIONAL ENGINEER

2/12/25

1	2/12/25	ADJUST TOB	GT	MJ	DS
REVISION No.	DATE	REVISION DESCRIPTION	MADE	CHECKED	APPROVED

THE STATE OF TEXAS

COUNTY OF GALVESTON

GALVESTON COUNTY

ENGINEERING DEPARTMENT

GALVESTON COUNTY ARPA



BACLIFF DRAINAGE IMPROVEMENTS

INDEX OF DRAWINGS

DESIGN BY: GWT	DATE: 2/12/2025	SHEET No. 2 OF 86
DRAWN BY: JKC	SCALE: N.T.S	JOB No. 5370-01
APPROVED: MJ		

G:\1180\5370-01 GALVESTON COUNTY ARPA - BACLIFF DRAINAGE IMPROVEMENTS\CAD\SHEETS\002-INDEX OF DRAWINGS.DWG

Wednesday, February 12, 2025 11:01:01 AM

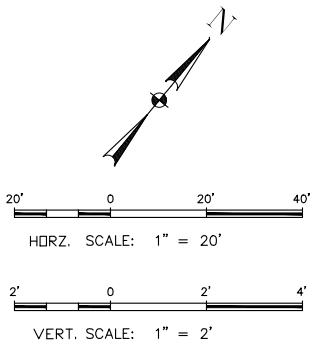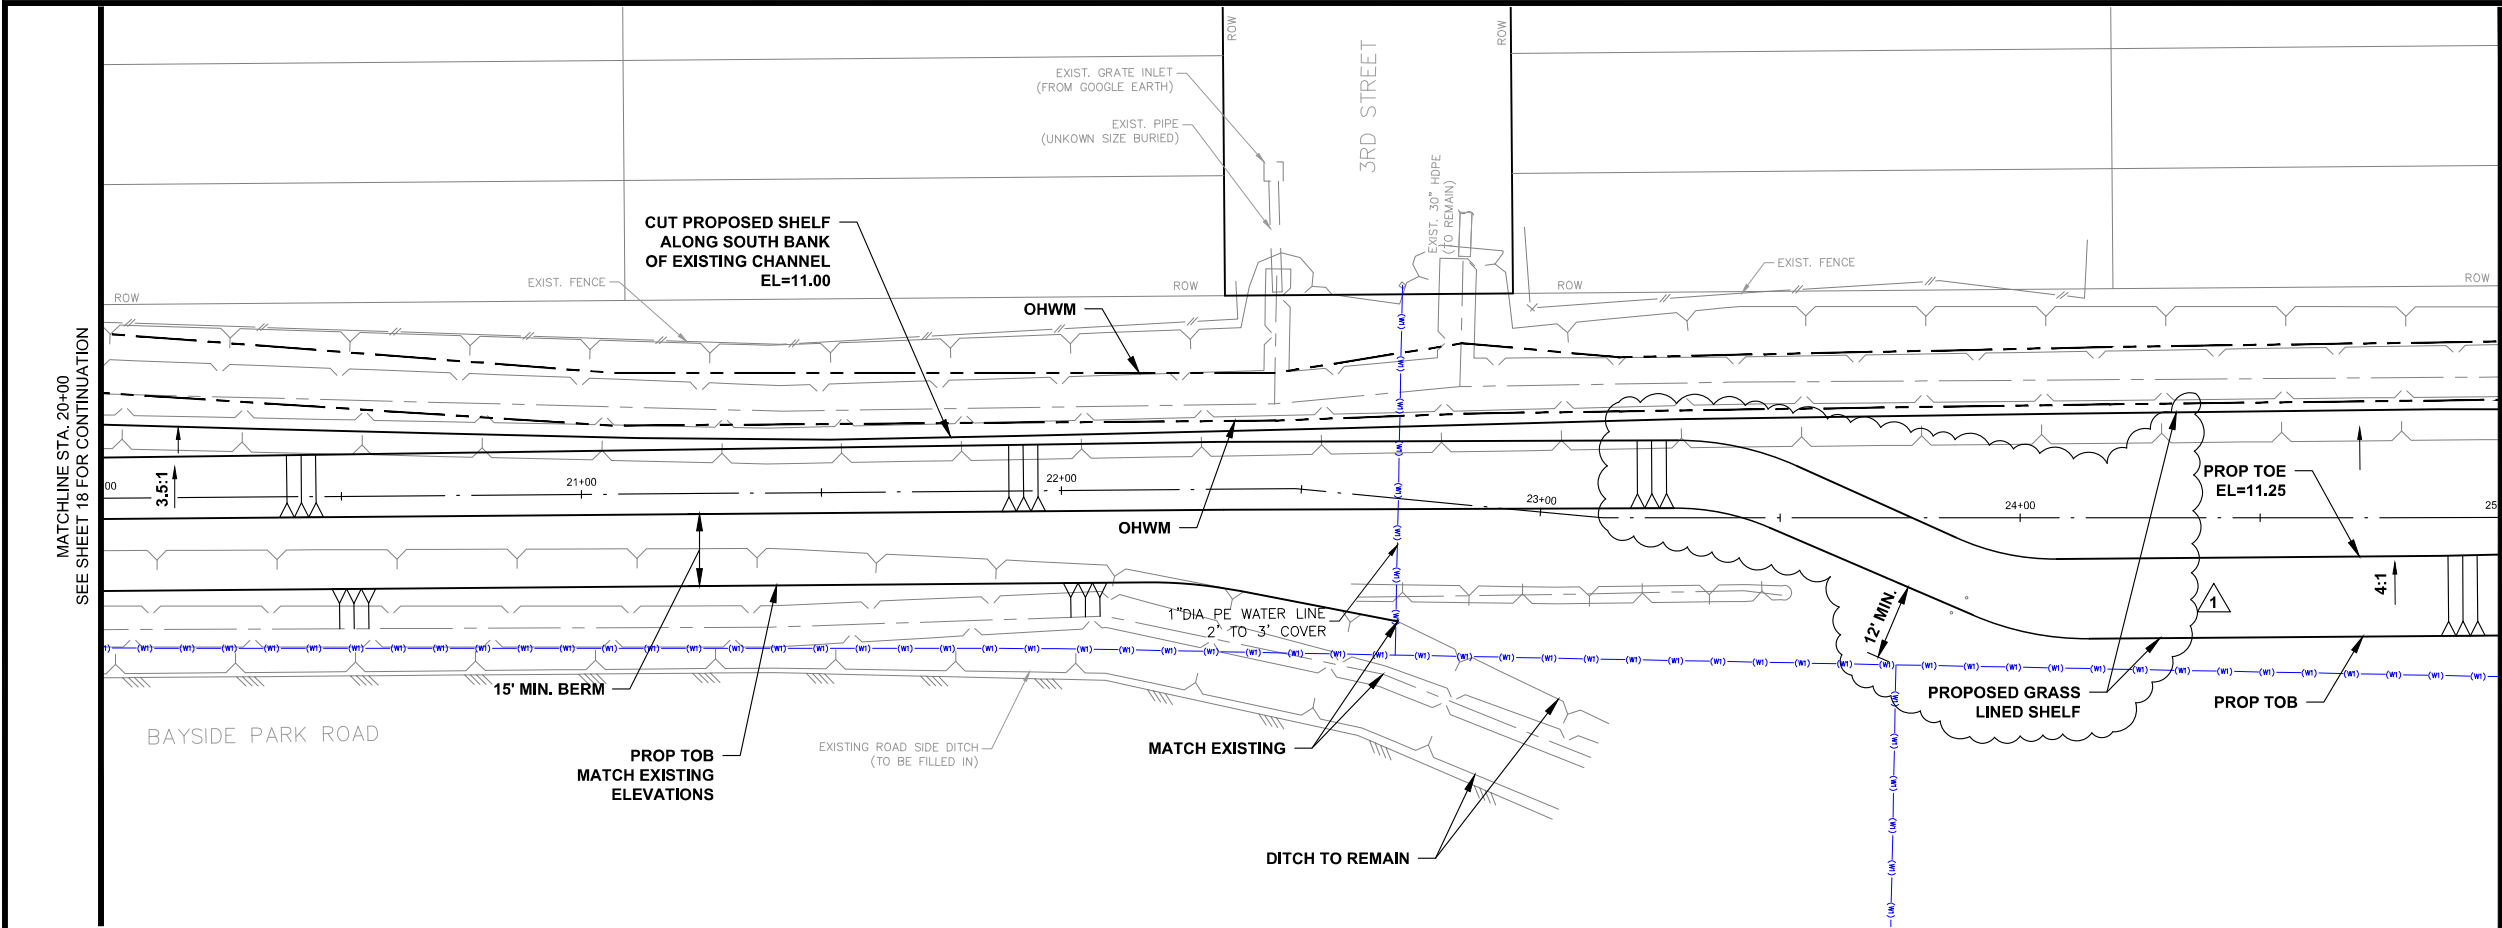


APPROXIMATE LOCATIONS ARE SHOWN FOR UTILITIES, CONTRACTOR TO VERIFY LOCATIONS OF ALL EXISTING UTILITIES AND TO COORDINATE RELOCATION OF ANY EXISTING UTILITIES THAT CONFLICT WITH CONSTRUCTION. NOTIFY ENGINEER'S OFFICE OF ALL CONFLICTS.

FOR LOCATIONS OF CHANNEL CROSS SECTIONS REFER TO SHEET 8 - 9 "PROJECT LAYOUT".

- NOTES:
- FOR CHANNEL IMPROVEMENT COORDINATES AND ELEVATIONS SEE SHEETS 37 AND 41

- LEGEND
- EXISTING COMCAST OVERHEAD COMMUNICATION LINE
 - EXISTING COMCAST COMMUNICATION LINE
 - EXISTING FRONTIER OVERHEAD COMMUNICATIONS LINE
 - EXISTING FRONTIER COMMUNICATIONS LINE
 - EXISTING CENTERPOINT OVERHEAD ELECTRIC LINE
 - EXISTING CENTERPOINT ELECTRIC LINE
 - EXISTING CENTERPOINT ENERGY GAS LINE
 - EXISTING LINDE GAS LINE
 - EXISTING BACLIFF MUD WASTEWATER LINE
 - EXISTING BACLIFF MUD WATER LINES

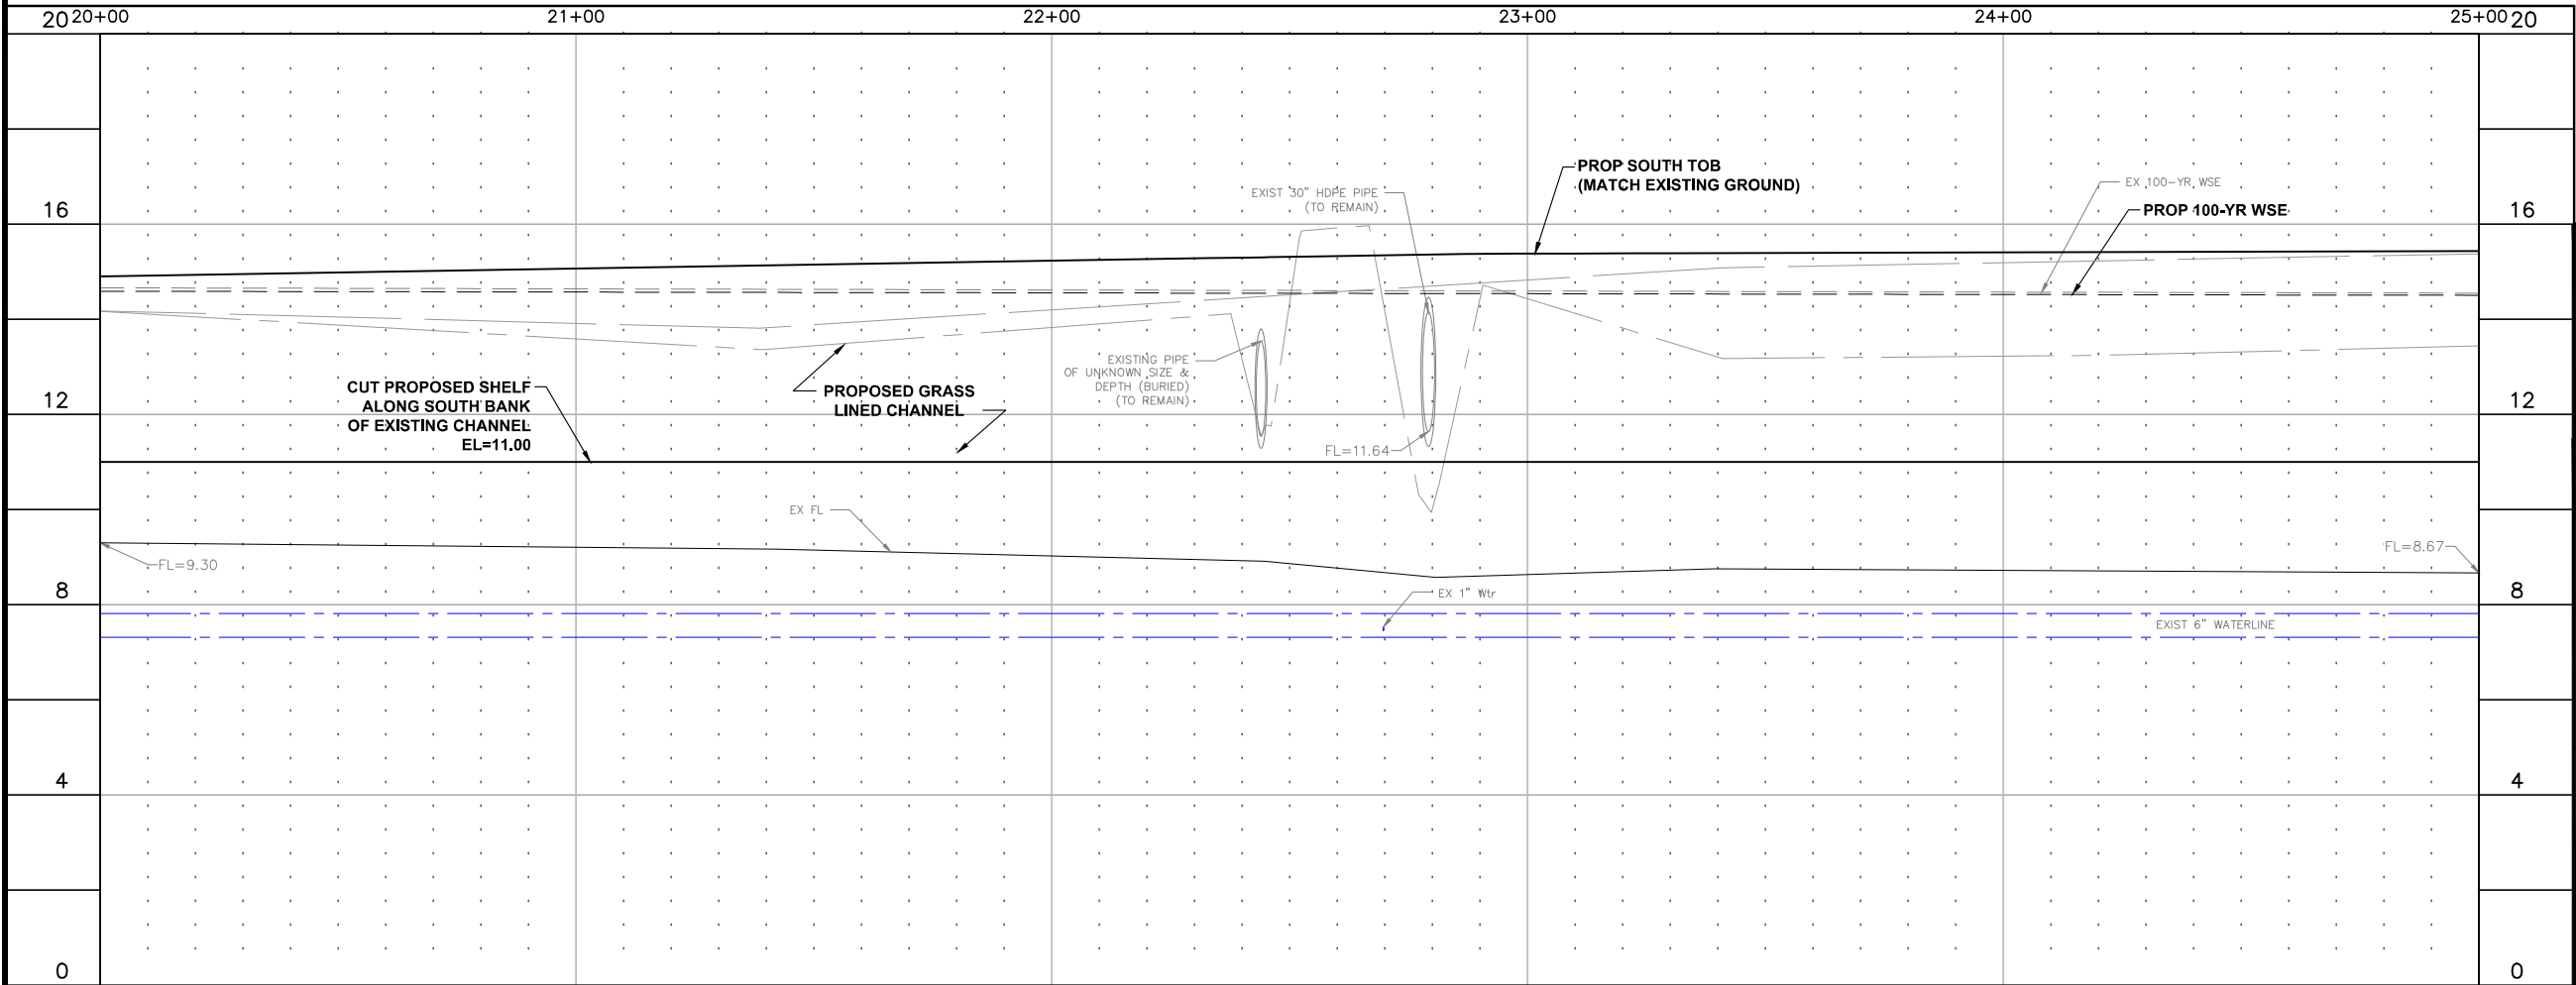

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ENGINEERING
EXCELLENCE
T.B.P.E.L.S. FIRM REGISTRATION #392
3100 WEST ALABAMA HOUSTON, TEXAS 77058 (713) 520-9570

SEAL

2/12/25

1	2/12/25	ADJUST TOB	GT	MJ	DS
REVISION No.	DATE	REVISION DESCRIPTION	MADE	CHECKED	APPROVED




GALVESTON COUNTY ARPA
BACLIFF DRAINAGE IMPROVEMENTS

DRAINAGE
PLAN & PROFILE
N-16 EAST DITCH (SHEET 5 OF 7)
STA 20+00 TO 25+00

DESIGN BY: GWT	DATE: 2/12/2025	SHEET No. 19 OF 86
DRAWN BY: JKC	SCALE: HORZ: 1" = 20' VERT: 1" = 2'	JOB No. 5370-01
APPROVED: MJ		

Wednesday, February 12, 2025 11:02:21 AM


MATCHLINE STA. 20+00
SEE SHEET 36 FOR CONTINUATION

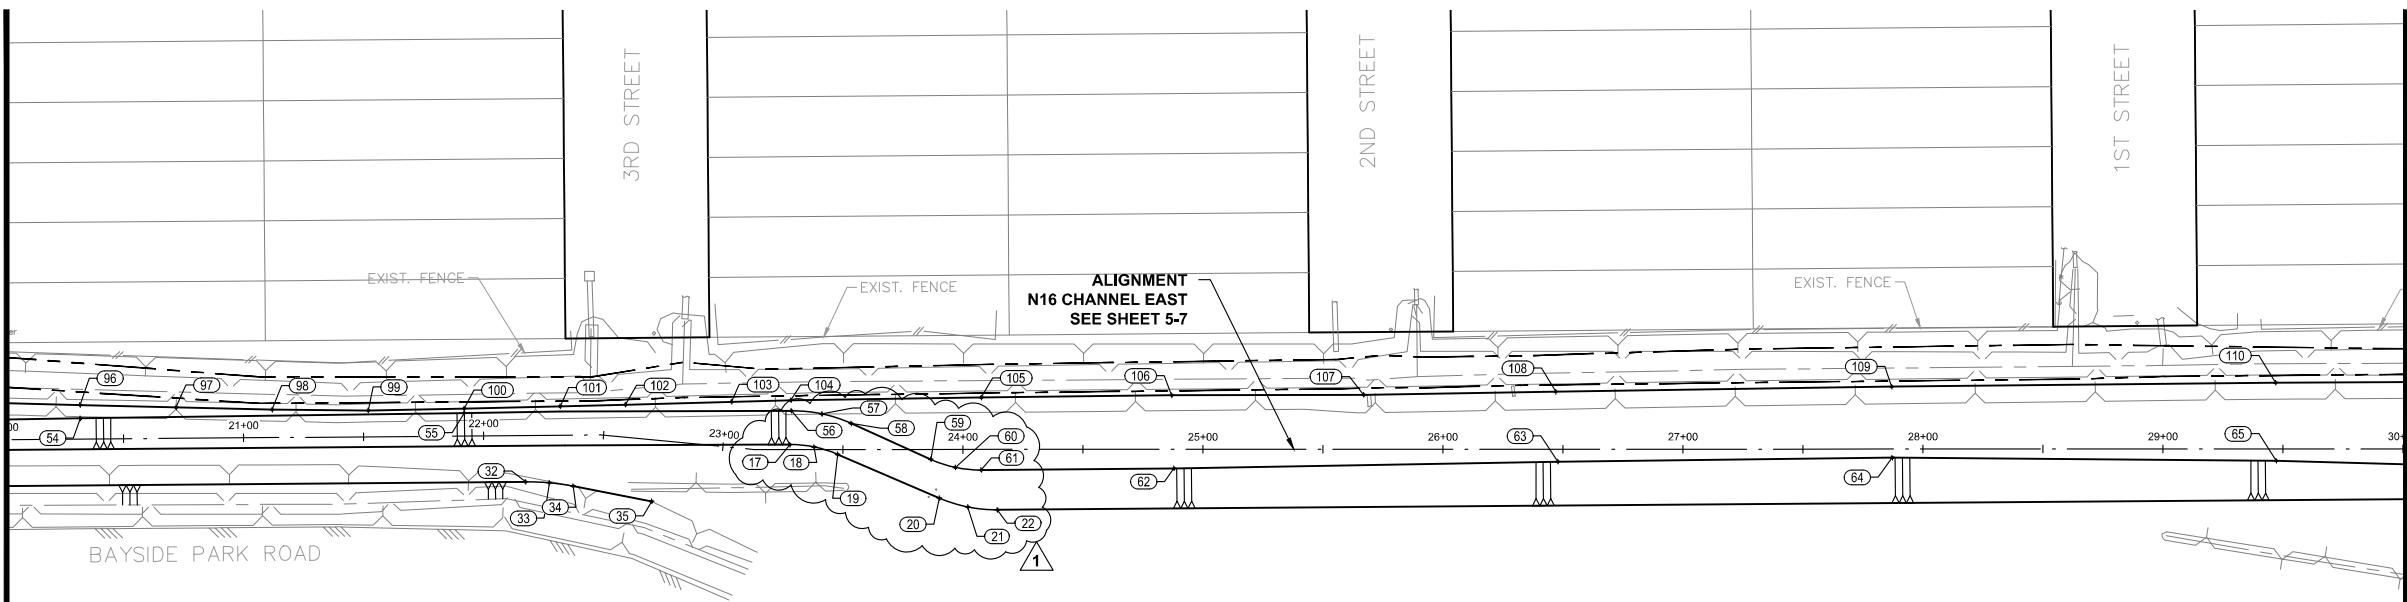

CALLED 49.61 ACRES
DICKINSON INDEPENDENT
SCHOOL DISTRICT
F.C. No. 2009007420
O.P.R.G.C.

CALLED 64.06 ACRES
OLD REDFISH FARM, LTD.,
F.C. No. 2008061074
O.P.R.G.C.


MATCHLINE STA. 30+00

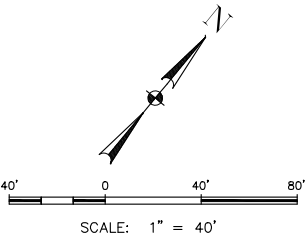

- NOTES:
- FOR CHANNEL IMPROVEMENT COORDINATES AND ELEVATIONS SEE SHEET 41

CAUTION!
OVERHEAD POWER
LINES IN THE AREA

MATCHLINE STA. 30+00

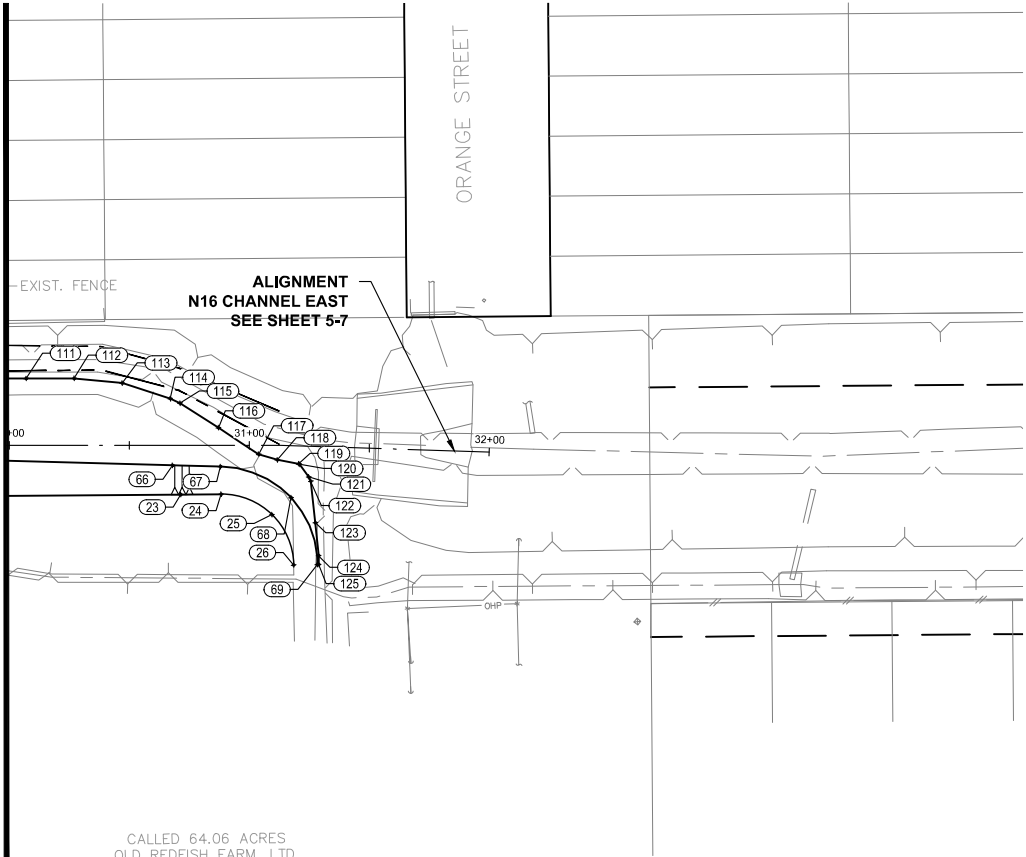

CALLED 64.06 ACRES
OLD REDFISH FARM, LTD.,
F.C. No. 2008061074
O.P.R.G.C.

DEC
ENGINEERING
EXCELLENCE
T.B.P.E.L.S. FIRM REGISTRATION #392
3100 WEST ALABAMA HOUSTON, TEXAS 77058 (713) 520-9570



2/12/25



GALVESTON COUNTY
ENGINEERING DEPARTMENT

GALVESTON COUNTY ARPA
BACLIFF DRAINAGE IMPROVEMENTS

N-16 EAST DITCH COORDINATE
LAYOUT (SHEET 2 OF 2)

THE COORDINATES SHOWN HEREON ARE SURFACE
COORDINATES AND MAY BE BROUGHT TO GRID BY
MULTIPLYING BY THE COMBINED SCALE FACTOR OF
0.99987064.

DESIGN BY: GWT	DATE: 2/12/2025	SHEET No. 37 OF 86
DRAWN BY: JKC	SCALE: 1" = 40'	JOB No. 5370-01
APPROVED: MJ		

ORIGINAL SCALE IN INCHES
FOR REDUCED PLANS

G:\1180\5370-01 GALVESTON COUNTY ARPA - BACLIFF DRAINAGE IMPROVEMENTS\CAD\SHEETS\036-041-CHANNEL COORDINATE LAYOUT.DWG

MATCHLINE STA. 72+00
SEE SHEET 39 FOR CONTINUATION

CALLLED 3.367 ACRES
BACLIFF MUNICIPAL UTILITY DISTRICT
H.C.C.F. No. 8702716
F.C. No. 005-05-0401
O.P.R.R.P.H.C.

CALLLED 3.367 ACRES
BACLIFF MUNICIPAL UTILITY DISTRICT
VOL 1687 PG 123
G.D.C.R.

CALLLED 0.426 ACRES
BACLIFF MUNICIPAL UTILITY DISTRICT
F.C. No2014060332
G.D.C.R.

REMAINDER OF
CALLLED 1079.700 ACRES
(CALLLED PARCEL PS11C-001)
NRG TEXAS, LP
C.F. No. 2002050899
C.F. No. 2006024657
G.D.C.R.

ALIGNMENT
N-16 10TH ST DITCH
SEE SHEET 5-7

10TH STREET

CHASE MORE COURT


CHASE MOUNTAIN DRIVE

Sanitary Manhole
Rim EL = 10.29'
12" P.V.C.(NW) = 0.34'


Sanitary Manhole
Rim EL = 11.66'
12" P.V.C.(SE) = 0.31'
30" P.V.C.(NW) = 0.42'
30" P.V.C.(SW) = 0.34'

Sanitary Manhole
Rim EL = 11.43'
30" P.V.C.(NW) = 0.18'
30" P.V.C.(SE) = 0.13'
12" P.V.C.(SW) = 0.36'

Sanitary Manhole
Rim EL = 11.92'
UNABLE TO OPEN

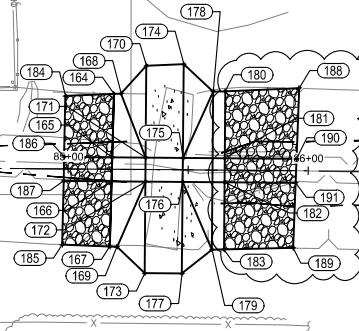

THE COORDINATES SHOWN HEREON ARE SURFACE
COORDINATES AND MAY BE BROUGHT TO GRID BY
MULTIPLYING BY THE COMBINED SCALE FACTOR OF
0.99987064.

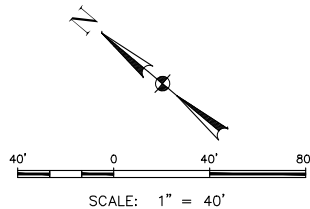

CAUTION!
UNDER GROUND POWER
LINES IN THE AREA

CAUTION!
UNDER GROUND
TELEPHONE LINES
IN THE AREA

CAUTION!
OVERHEAD POWER
LINES IN THE AREA

CAUTION!
GAS LINES
IN THE AREA

DEC
ENGINEERING
EXCELLENCE
T.B.P.E.L.S. FIRM REGISTRATION #392
3100 WEST ALABAMA HOUSTON, TEXAS 77008 (713) 520-8570



2/12/25



GALVESTON COUNTY
ENGINEERING DEPARTMENT

GALVESTON COUNTY ARPA
BACLIFF DRAINAGE IMPROVEMENTS

10TH STREET CHANNEL
COORDINATE LAYOUT

DESIGN BY: GWT	DATE: 2/12/2025	SHEET No. 40 OF 86
DRAWN BY: JKC	SCALE: 1" = 40'	JOB No. 5370-01
APPROVED: MJ		

N16 EAST CHANNEL COORDINATE AND ELEVATIONS				
Point #	Elevation	Northing	Easting	Description
1	14.48	13753649.51	3246095.31	TOB *
2	14.46	13753655.60	3246104.44	TOB *
3	14.46	13753659.54	3246114.68	TOB *
4	14.46	13753662.05	3246124.16	TOB *
5	14.45	13753666.63	3246135.59	TOB *
6	14.42	13753673.85	3246145.58	TOB *
7	14.30	13753752.64	3246236.71	TOB *
8	14.37	13753764.56	3246250.26	TOB *
9	14.52	13753893.12	3246402.52	TOB *
10	14.67	13754023.26	3246556.83	TOB *
11	14.33	13754150.54	3246711.14	TOB *
12	13.76	13754279.62	3246864.41	TOB *
13	13.28	13754405.03	3247018.62	TOB *
14	14.37	13754534.71	3247170.82	TOB *
15	14.49	13754607.38	3247257.63	TOB *
16	14.48	13754627.31	3247281.34	TOB *
17	15.51	13755041.28	3247775.42	TOB *
18	15.94	13755046.98	3247783.91	TOB *
19	15.70	13755050.83	3247793.38	TOB *
20	15.94	13755063.76	3247837.71	TOB *
21	15.79	13755068.44	3247849.19	TOB *
22	15.72	13755075.37	3247859.45	TOB *
23	14.21	13755497.35	3248363.07	TOB *
24	13.94	13755508.16	3248375.97	TOB *
25	13.79	13755515.06	3248397.73	TOB *
26	13.72	13755504.65	3248418.05	TOB *
27	14.66	13753620.59	3246106.92	TOB *
28	13.94	13753741.30	3246246.52	TOB *
29	14.90	13753609.25	3246116.19	TOB *
30	14.37	13753739.82	3246271.42	TOB *
31	14.86	13754615.87	3247291.05	TOB *
32	15.25	13754959.25	3247700.31	TOB *
33	15.27	13754965.28	3247708.27	TOB *
34	15.28	13754970.48	3247716.79	TOB *
35	15.10	13754986.41	3247746.07	TOB *
36	14.23	13753614.89	3246111.56	TOE
37	12.74	13753745.66	3246263.02	TOE
38	11.00	13753655.18	3246090.57	TOE
39	11.21	13753665.60	3246104.29	TOE
40	11.25	13753671.10	3246114.22	TOE
41	11.26	13753676.61	3246130.38	TOE
42	11.25	13753681.07	3246136.70	TOE
43	11.25	13753807.55	3246283.96	TOE
44	11.25	13753901.51	3246395.43	TOE
45	11.25	13753987.96	3246498.10	TOE
46	11.25	13754103.03	3246636.67	TOE
47	11.25	13754192.36	3246744.32	TOE
48	11.25	13754286.98	3246858.21	TOE
49	11.25	13754382.09	3246976.92	TOE
50	11.25	13754472.23	3247083.76	TOE

N16 EAST CHANNEL COORDINATE AND ELEVATIONS				
Point #	Elevation	Northing	Easting	Description
51	11.25	13754576.63	3247205.13	TOE
52	11.25	13754680.35	3247326.94	TOE
53	11.25	13754770.96	3247433.67	TOE
54	11.25	13754861.56	3247540.40	TOE
55	11.25	13754965.11	3247662.38	TOE
56	11.25	13755052.61	3247766.99	TOE
57	11.25	13755059.69	3247777.64	TOE
58	11.25	13755064.36	3247789.56	TOE
59	11.25	13755073.93	3247824.69	TOE
60	11.25	13755077.88	3247834.72	TOE
61	11.25	13755083.88	3247843.68	TOE
62	11.25	13755135.51	3247905.20	TOE
63	11.25	13755239.49	3248026.82	TOE
64	11.25	13755329.45	3248133.19	TOE
65	11.25	13755430.31	3248257.42	TOE
66	11.25	13755504.56	3248352.66	TOE
67	11.25	13755516.87	3248368.44	TOE
68	11.25	13755525.62	3248399.35	TOE
69	11.25	13755511.07	3248425.55	TOE
70	11.00	13753662.88	3246100.01	SHELF
71	11.00	13753696.06	3246140.71	SHELF
72	11.00	13753721.33	3246171.74	SHELF
73	11.00	13753759.28	3246218.25	SHELF
74	11.00	13753798.77	3246263.76	SHELF
75	11.00	13753811.72	3246279.00	SHELF
76	11.00	13753863.54	3246339.95	SHELF
77	11.00	13753907.04	3246390.84	SHELF
78	11.00	13753992.48	3246492.86	SHELF
79	11.00	13754030.97	3246538.88	SHELF
80	11.00	13754043.98	3246554.39	SHELF
81	11.00	13754108.63	3246630.70	SHELF
82	11.00	13754146.43	3246677.29	SHELF
83	11.00	13754171.59	3246708.09	SHELF
84	11.00	13754197.19	3246738.82	SHELF
85	11.00	13754292.61	3246853.55	SHELF
86	11.00	13754350.52	3246923.96	SHELF
87	11.00	13754388.54	3246970.37	SHELF
88	11.00	13754418.51	3247007.14	SHELF
89	11.00	13754479.11	3247077.90	SHELF
90	11.00	13754531.24	3247138.58	SHELF
91	11.00	13754583.18	3247199.64	SHELF
92	11.00	13754673.23	3247306.81	SHELF
93	11.00	13754777.83	3247427.91	SHELF
94	11.00	13754803.92	3247458.23	SHELF
95	11.00	13754828.87	3247489.51	SHELF
96	11.00	13754865.81	3247536.84	SHELF
97	11.00	13754890.51	3247568.33	SHELF
98	11.00	13754915.25	3247599.79	SHELF
99	11.00	13754940.46	3247630.85	SHELF
100	11.00	13754966.54	3247661.18	SHELF

N16 EAST CHANNEL COORDINATE AND ELEVATIONS				
Point #	Elevation	Northing	Easting	Description
101	11.00	13754992.71	3247691.44	SHELF
102	11.00	13755010.55	3247712.03	SHELF
103	11.00	13755039.59	3247745.33	SHELF
104	11.00	13755055.87	3247764.00	SHELF
105	11.00	13755107.25	3247824.50	SHELF
106	11.00	13755158.43	3247885.09	SHELF
107	11.00	13755209.49	3247946.69	SHELF
108	11.00	13755261.39	3248007.57	SHELF
109	11.00	13755352.11	3248114.20	SHELF
110	11.00	13755455.21	3248236.56	SHELF
111	11.00	13755493.66	3248282.62	SHELF
112	11.00	13755506.41	3248298.03	SHELF
113	11.00	13755517.64	3248314.72	SHELF
114	11.00	13755525.39	3248334.31	SHELF
115	11.00	13755526.53	3248338.62	SHELF
116	11.00	13755528.84	3248357.51	SHELF
117	11.00	13755530.95	3248377.44	SHELF
118	11.00	13755534.10	3248384.94	SHELF
119	11.00	13755538.50	3248392.89	SHELF
120	11.00	13755538.56	3248393.27	SHELF
121	11.00	13755536.95	3248399.55	SHELF
122	11.00	13755536.11	3248401.35	SHELF
123	11.00	13755523.99	3248413.81	SHELF
124	11.00	13755514.28	3248423.63	SHELF
125	11.00	13755511.46	3248426.00	SHELF



N16 WEST CHANNEL COORDINATE AND ELEVATIONS				
Point #	Elevation	Northing	Easting	Description
126	9.49	13751489.46	3243482.54	DESILT
127	9.49	13751487.92	3243483.82	DESILT
128	9.24	13751627.16	3243650.70	DESILT
129	9.24	13751625.61	3243651.96	DESILT
130	9.97	13751635.93	3243659.04	DESILT
131	9.84	13751632.06	3243662.21	DESILT
132	9.55	13751649.93	3243676.13	DESILT
133	9.48	13751646.06	3243679.30	DESILT
134	8.77	13751654.85	3243684.47	DESILT
135	8.77	13751653.31	3243685.75	DESILT
136	8.70	13751707.71	3243747.79	DESILT
137	8.70	13751706.17	3243749.07	DESILT
138	8.66	13751740.52	3243785.53	DESILT
139	8.66	13751737.45	3243788.09	DESILT
140	8.10	13752173.48	3244304.17	DESILT
141	8.10	13752170.41	3244306.73	DESILT
142	7.54	13752603.46	3244822.89	DESILT
143	7.54	13752600.38	3244825.44	DESILT
144	7.52	13752622.28	3244839.80	DESILT
145	7.52	13752613.46	3244847.19	DESILT
146	7.50	13752648.40	3244870.95	DESILT
147	7.50	13752639.59	3244878.34	DESILT
148	7.50	13752660.30	3244893.78	DESILT
149	7.48	13752655.61	3244897.52	DESILT
150	7.47	13753588.45	3246005.33	DESILT
151	6.60	13753549.45	3245968.17	DESILT
152	6.57	13753573.64	3246018.74	DESILT
153	6.57	13753543.97	3245983.37	DESILT
154	6.47	13753497.92	3246066.19	DESILT
155	6.47	13753484.20	3246049.84	DESILT
156	7.69	13753476.29	3246079.30	DESILT
157	7.57	13753466.85	3246068.06	DESILT
158	9.23	13751634.00	3243660.62	WINGWALL
159	8.78	13751648.00	3243677.71	WINGWALL
160	7.52	13752617.87	3244843.50	WINGWALL
161	7.50	13752641.43	3244876.79	WINGWALL
162	6.55	13753542.40	3246014.94	WINGWALL
163	6.48	13753506.96	3246044.68	WINGWALL

N16 10TH ST. CHANNEL COORDINATE AND ELEVATIONS				
Point #	Elevation	Northing	Easting	Description
164	9.52	13752177.52	3247205.28	CONC
165	3.05	13752161.12	3247184.51	CONC
166	3.05	13752154.92	3247176.66	CONC
167	10.03	13752138.06	3247155.31	CONC
168	9.53	13752175.29	3247207.30	CONC
169	10.03	13752135.69	3247157.14	CONC
170	10.94	13752174.59	3247222.94	CONC
171	3.03	13752150.31	3247193.36	CONC
172	3.03	13752143.97	3247185.63	CONC
173	10.29	13752119.76	3247156.12	CONC
174	10.26	13752163.03	3247233.39	CONC
175	3.01	13752138.31	3247203.19	CONC
176	3.01	13752131.98	3247195.45	CONC
177	10.23	13752107.81	3247165.91	CONC
178	9.73	13752146.32	3247232.50	CONC
179	10.04	13752104.55	3247181.60	CONC
180	9.88	13752142.53	3247235.77	CONC
181	1.02	13752124.85	3247214.21	CONC
182	1.02	13752118.51	3247206.48	CONC
183	10.07	13752100.73	3247184.82	CONC
184	9.35	13752192.47	3247191.69	RIPRAP
185	10.34	13752153.77	3247143.19	RIPRAP
186	3.08	13752176.61	3247171.82	RIPRAP
187	3.07	13752170.38	3247164.00	RIPRAP
188	9.75	13752119.74	3247256.56	RIPRAP
189	9.86	13752079.00	3247203.78	RIPRAP
190	1.30	13752101.69	3247233.18	RIPRAP
191	1.31	13752095.58	3247225.26	RIPRAP






LEGEND

TOB TOP OF BANK
TOE TOE OF SLOPE
SHELF DAY LIGHT LINE AT EXISTING CHANNEL
DESILT ELEVATION OF CHANNEL CLEANING
* MATCH NG



THE COORDINATES SHOWN HEREON ARE SURFACE COORDINATES AND MAY BE BROUGHT TO GRID BY MULTIPLYING BY THE COMBINED SCALE FACTOR OF 0.99987064.

 T.B.P.E.L.S. FIRM REGISTRATION #392 3100 WEST ALABAMA HOUSTON, TEXAS 77058 (713) 524-6570		 2/12/25	
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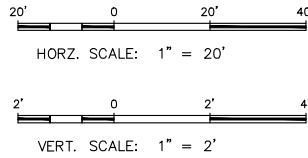
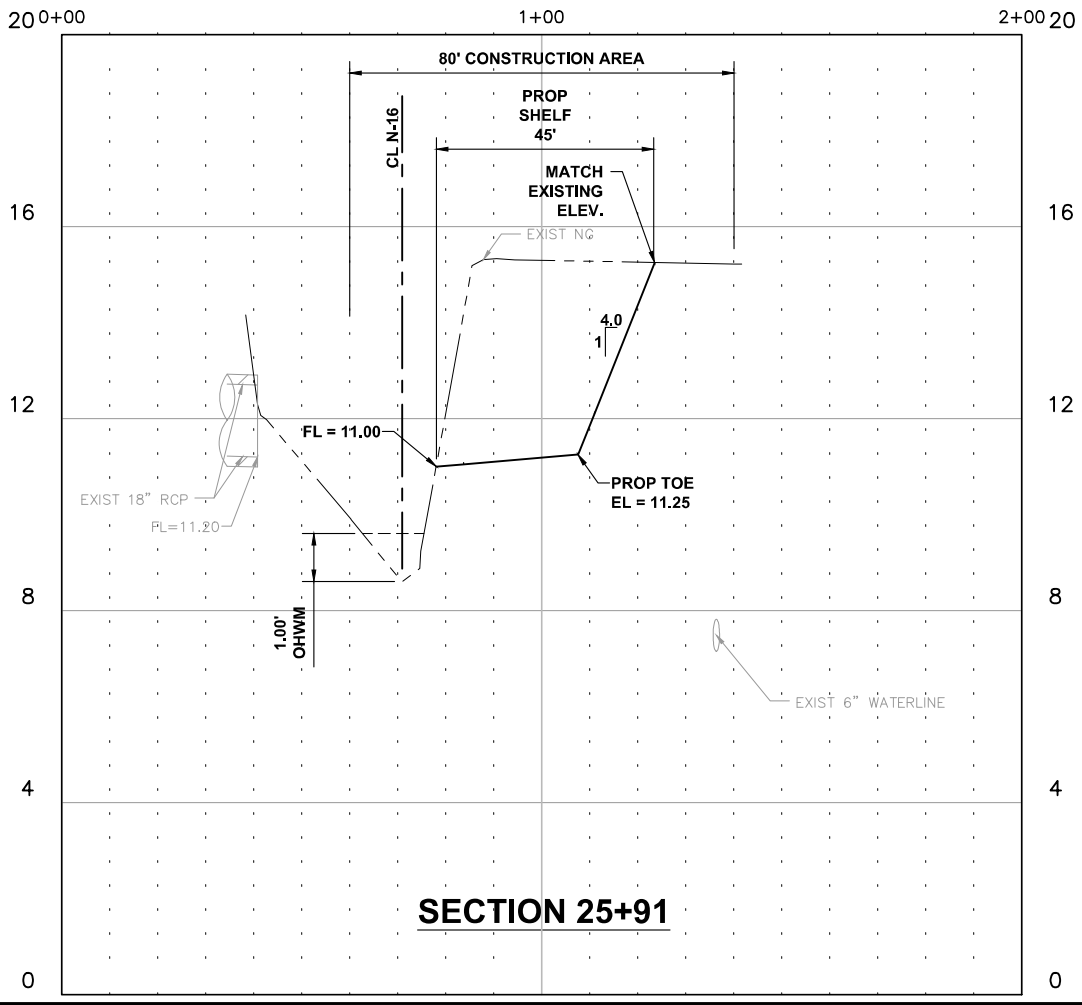
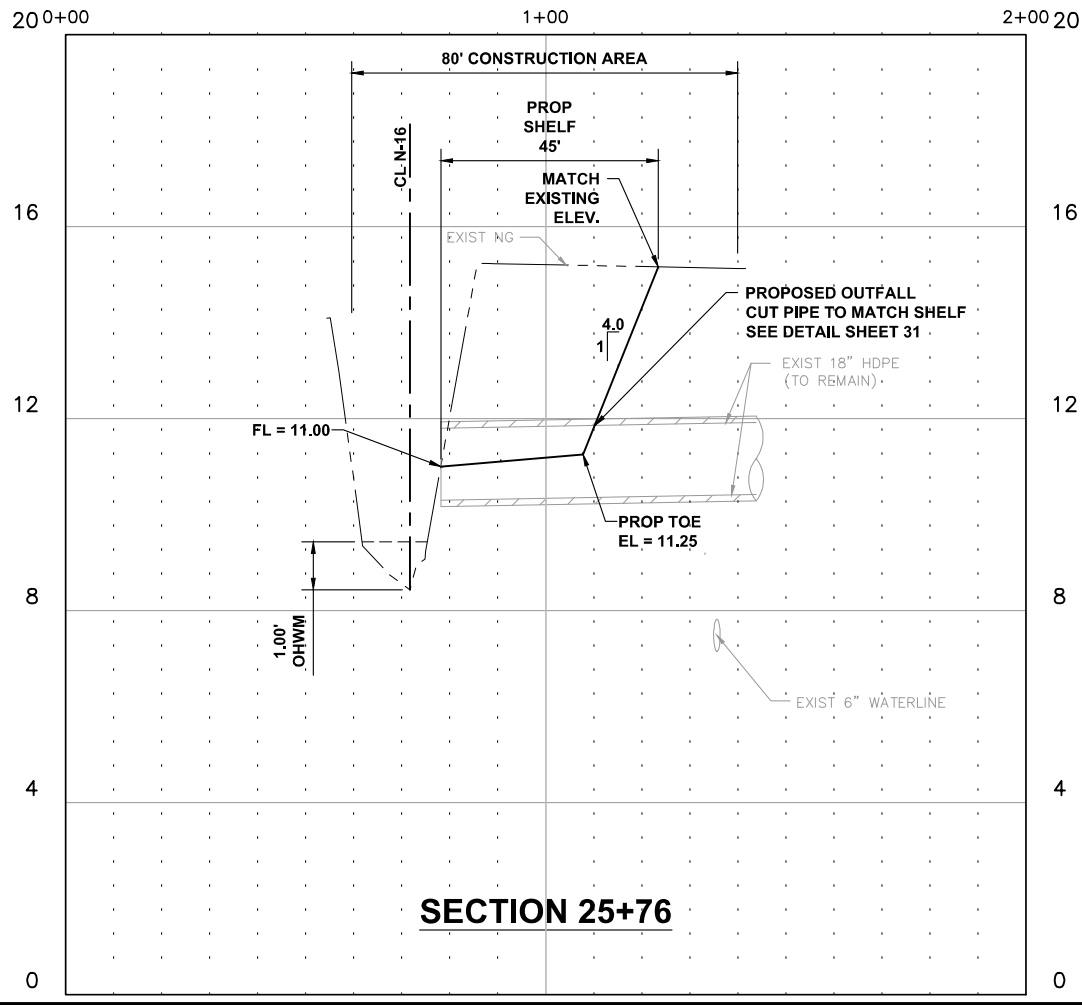
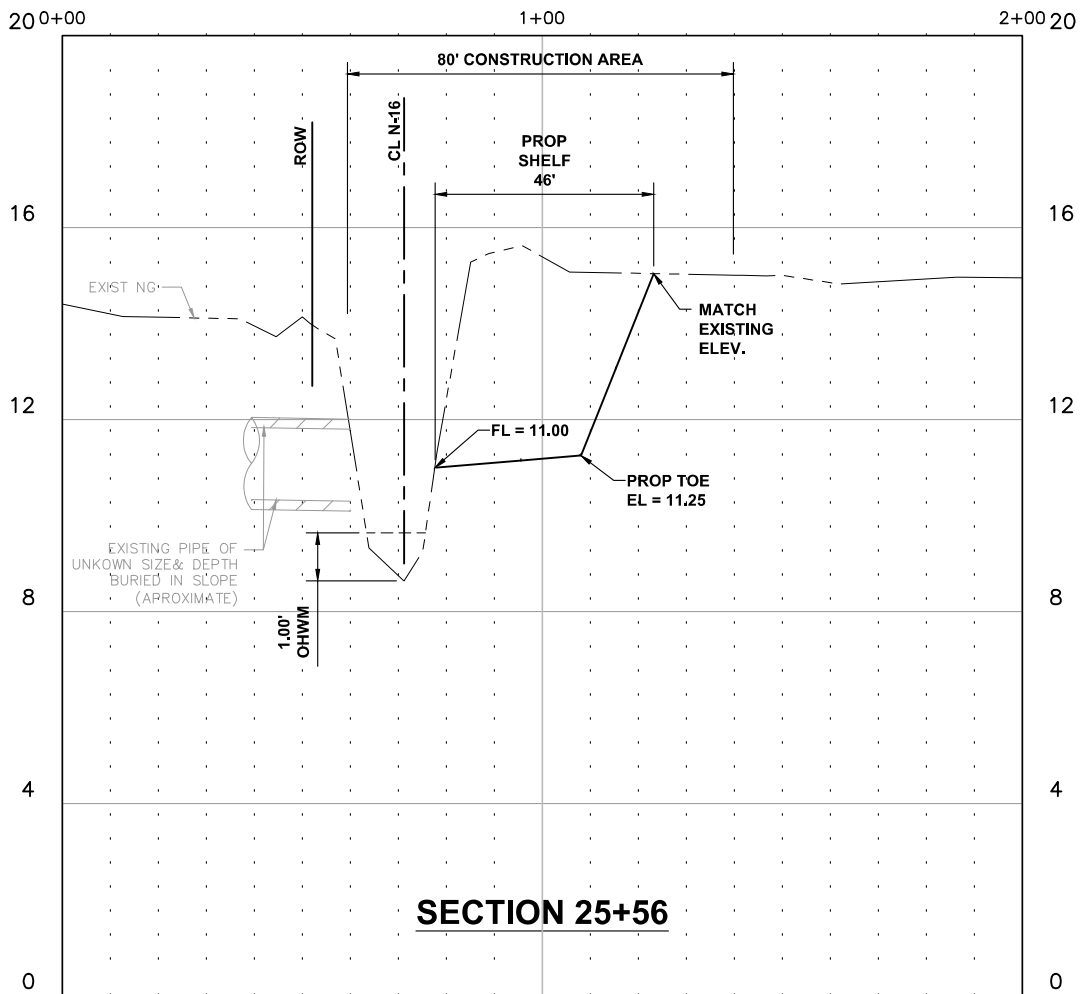
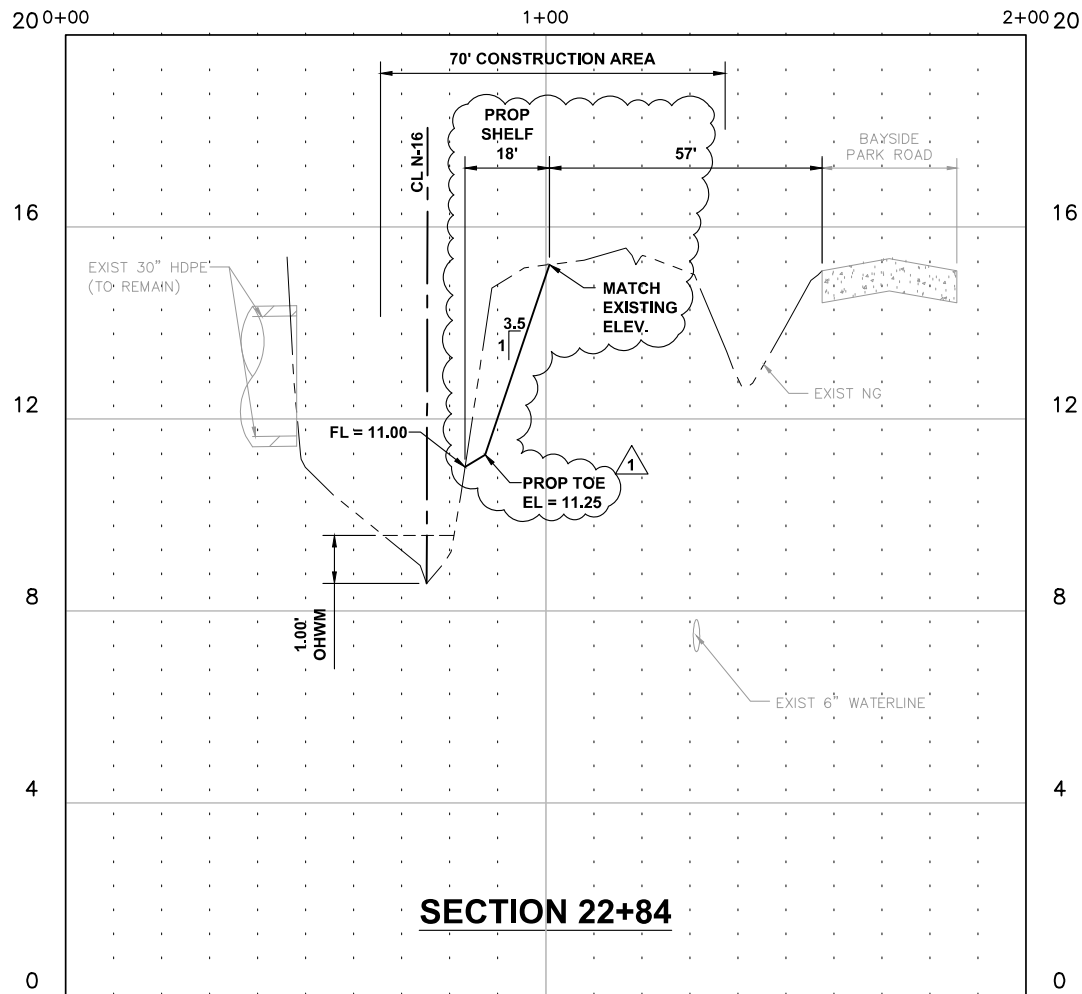
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

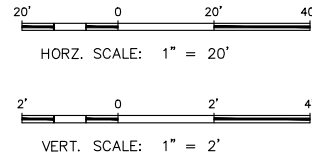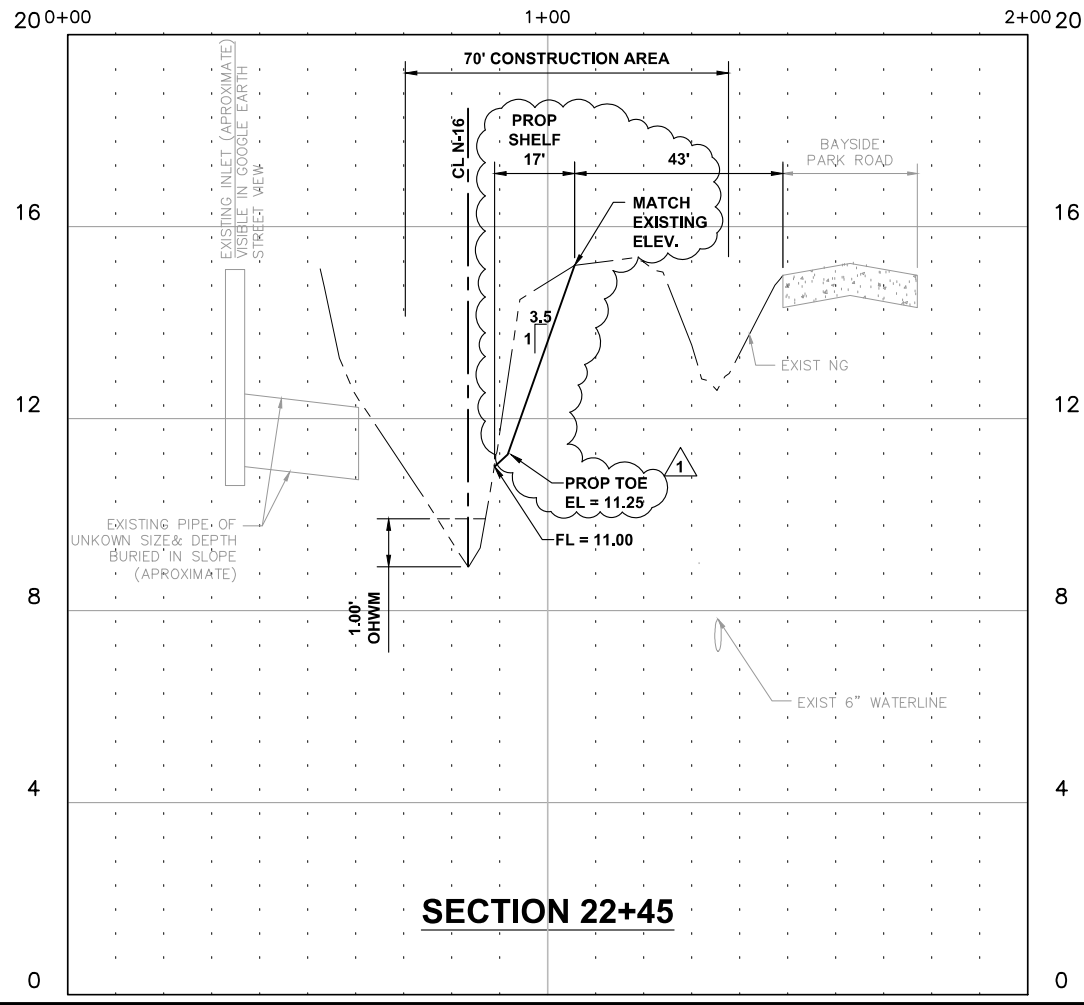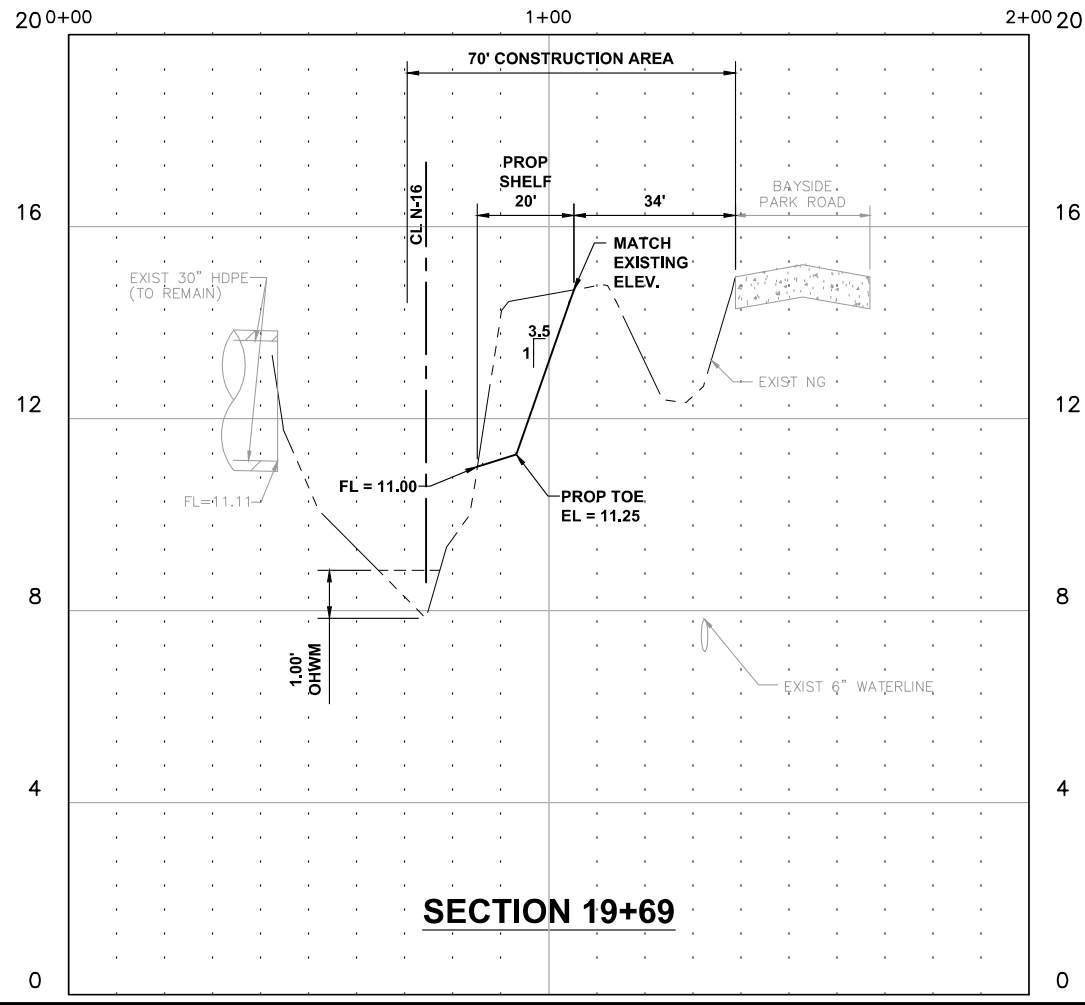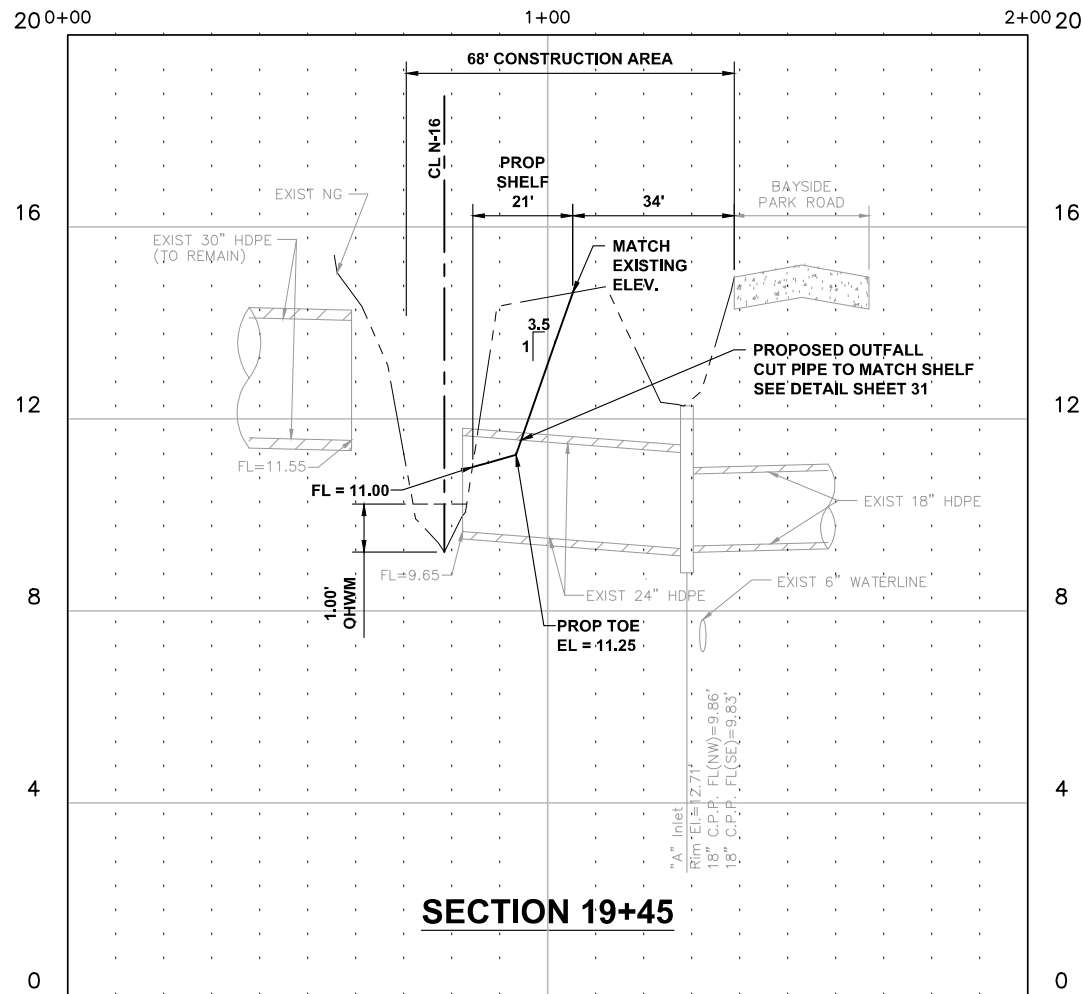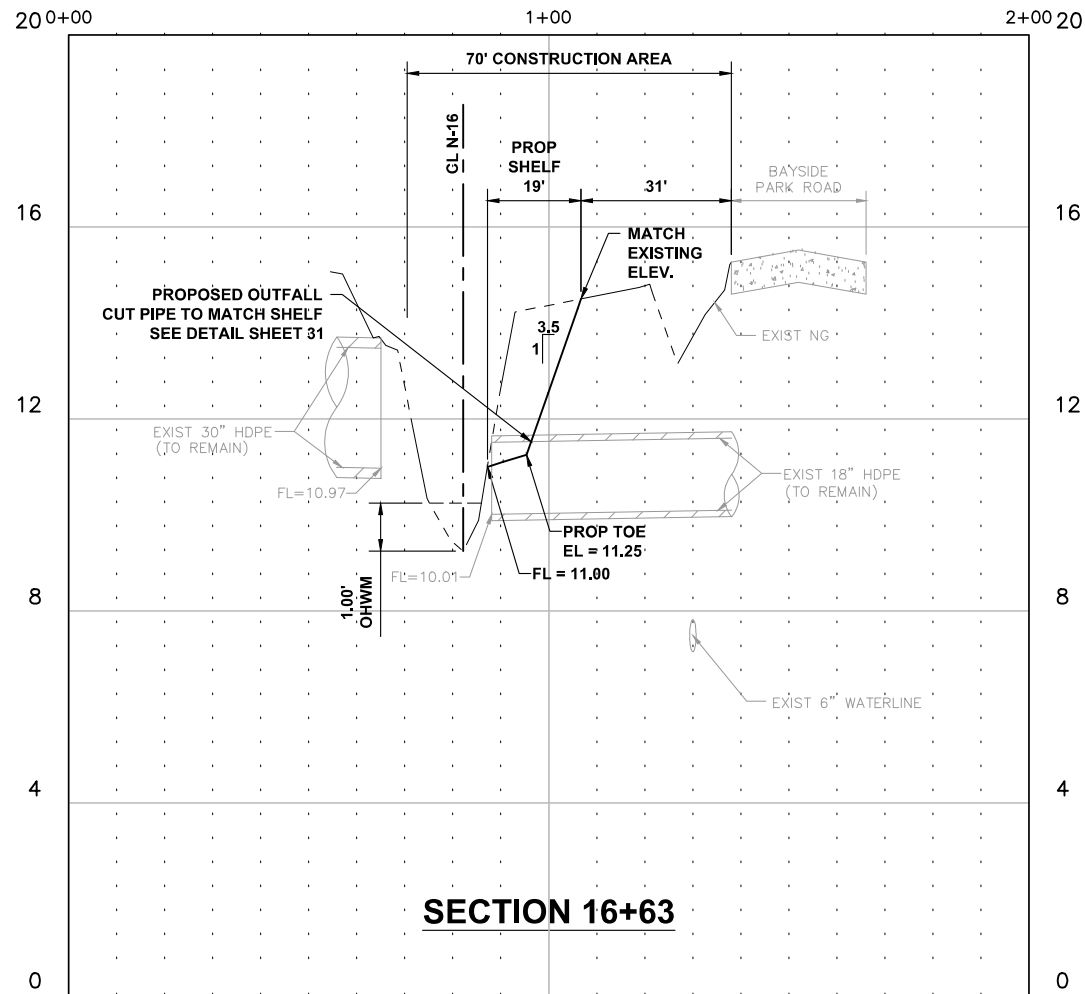NOTES:
1. FOR MH DETAILS SEE SHEET 58

DEC ENGINEERING EXCELLENCE T.B.P.E.L.S. FIRM REGISTRATION #392 3100 WEST ALABAMA HOUSTON, TEXAS 77058 (713) 520-8570		SEAL  2/12/25			
1	2/12/25	ADJUST TOB	GT	MJ	DS
REVISION No.	DATE	REVISION DESCRIPTION	MADE	CHECKED	APPROVED
		GALVESTON COUNTY ENGINEERING DEPARTMENT			
GALVESTON COUNTY ARPA BACLIF DRAINAGE IMPROVEMENTS					
N-16 EAST CROSS-SECTIONS (SHEET 4 OF 6)					
DESIGN BY: GWT	DATE: 2/12/2025	SHEET No. 45 OF 86			
DRAWN BY: JKC	SCALE: HORZ: 1" = 20' VERT: 1" = 2'	JOB No. 5370-01			
APPROVED: MJ					

Wednesday, February 12, 2025 11:03:54 AM



- NOTES:
1. FOR MH DETAILS SEE SHEET 58

DEC ENGINEERING EXCELLENCE <small>T.B.P.E.L.S. FIRM REGISTRATION #392 3100 WEST ALABAMA HOUSTON, TEXAS 77068 (713) 520-9570</small>		SEAL  2/12/25			
1	2/12/25	ADJUST TOB	GT	MJ	DS
REVISION No.	DATE	REVISION DESCRIPTION	MADE	CHECKED	APPROVED
		GALVESTON COUNTY ENGINEERING DEPARTMENT			
GALVESTON COUNTY ARPA BACLIFF DRAINAGE IMPROVEMENTS					
N-16 EAST CROSS-SECTIONS (SHEET 5 OF 6)					
DESIGN BY: GWT		DATE: 2/12/2025		SHEET No. 46 OF 86	
DRAWN BY: JKC		SCALE: HORZ: 1" = 20' VERT: 1" = 2'		JOB No. 5370-01	
APPROVED: MJ					

